

SCHEDULE OF COLOURS & FINISHES:

-  R1
RENDER & PAINT
DULUX - DOMINO
-  BR
BRICK WALL
-  MC
METAL CLADDING
MINI ORB CLADDING
CONCRETE FINISH WALL
-  GB
FROSTED GLASS BALUSTRADE
-  TL
METAL CLADDING
TIMBER FINISH
LINING/LOUVERS
-  R2
RENDER & PAINT
DULUX - BROWN
-  AF1
ALUMINIUM FRAME
POWDER COAT FINISH
CHARCOAL GREY
WINDOWS AND DOORS



1 SOUTH-EAST ELEVATION-HOMER ST
SCALE 1:200 @ A1

LEGEND
PROPOSED DA AMENDMENTS SHOWN IN BLUE



2 NORTH-WEST ELEVATION- WARDELL RD
SCALE 1:200 @ A1

BASIX COMMITMENTS NOTES			
* TO BE READ IN CONJUNCTION WITH APPROVED BASIX REPORT*			
WATER	Fixtures	All Shower Heads 4 star (600<<7.5l/min)	All toilet flushing systems 4 star All kitchen taps 4 star All bathroom taps 5 star
Appliances:	Dishwashers	5.0 star water rating	
Alternative water source	Central rainwater tank	size 5000L to collect run-off from at least 269m ² of roof area and connection to allow for irrigation of 200m ² of common landscape area	
Fire	Fire sprinklers	are to be configured so that fire sprinkler test water is contained within the fire sprinkler system for re-use, rather than disposed.	
ENERGY	Hot water system:	Central hot water system - gas instantaneous	
Boothroom ventilation system:	Individual fan,	ducted to facade or roof manual switch on/off	
Kitchen ventilation system:	Individual fan,	ducted to facade or roof manual switch on/off	
Laundry ventilation system:	Individual fan,	ducted to facade or roof manual switch on/off	
COOLING	Cooling system:	air-conditioning 1 Phase - EER 3.0-3.5 living/bed (zoned)	
Heating system:	air-conditioning 1 Phase -	EER 3.0-3.5 living/bed (zoned)	
Artificial lighting:	As per BASIX		
Natural lighting:	As per BASIX		
Appliances:	Gas cooktop & electric oven	in the kitchen of the dwellings	
Dishwashers:	3.5 star energy rating		
Alternative energy supply:	Photovoltaic system - Rated electrical output (min): 21.0 peak kW		
COMMON AREAS	Refer to approved BASIX cert		

NATHERS summary for 221-235 & 241 Homer Street Earlwood 2206		
Building Elements	Material	Detail
External walls - Levels 1 & 2	Brick veneer	R2.5 insulation (product value)
External walls - Levels 3 to 6	Lightweight metal clad walls	R2.5 insulation (product value)
Internal walls within units	Plasterboard on studs	-
Common walls between units & Corridors	Hebel + stud + Plasterboard	-
Common walls between units	Hebel + stud + Plasterboard	-
Common walls between units and lift shaft/fire stairs	200mm concrete	-
Ceilings to nominated units	Plasterboard	R1.5 insulation (product value) to ceilings with roof to outside air units - A2.01, A2.02, A1.02, A2.01, R2.02, R2.01, C1.02, C1.01, C1.09
Ceilings to top floor units	Plasterboard	R1.5 insulation (product value) to ceilings with roof above - B5.04, B5.05, C5.01, C5.02, C5.03 & Level 6 units
Floors	Concrete	-
Roof	Concrete roof	-
Windows/Doors to all units except as stated below	Sliding windows/doors, fixed R. Inset windows: Aluminium frame, single glazed clear	U value 6.70 or less and SHGC 0.70 +/- 10%
Windows/Doors to units - A3.01, A3.02, A4.01, A4.02, A5.01, A5.02, A6.01, A6.02, B1.01, B1.02, B2.01, B2.02, B3.01, B3.02, B4.01, B4.02, B5.01, B5.02, B5.03, B5.99, B5.100	U value 6.70 or less and SHGC 0.57 +/- 10%	
Windows/Doors to units - A3.01, A3.02, A4.01, A4.02, A5.01, A5.02, A6.01, A6.02, B1.01, B1.02, B2.01, B2.02, B3.01, B3.02, B4.01, B4.02, B5.01, B5.02, B5.03, B5.99, B5.100	U value 4.30 or less and SHGC 0.53 +/- 10%	
Windows/Doors to units - A3.01, A3.02, A4.01, A4.02, A5.01, A5.02, A6.01, A6.02, B1.01, B1.02, B2.01, B2.02, B3.01, B3.02, B4.01, B4.02, B5.01, B5.02, B5.03, B5.99, B5.100	U value 5.40 or less and SHGC 0.49 +/- 10%	
Ceiling fans	1200mm ceiling fans to living and bedrooms - Units B1.03, 2.03	-
	1200mm ceiling fans to living only - Units B3.02, B4.02, B5.02, B6.02	-

Scale: 1:200 @A1 1:400 @A3
0 2 4 6 8 10
Date Printed: 25/10/2024

ISSUE	REVISION DESCRIPTION	APPD	DATE
H	ISSUE FOR DA AMENDMENTS	HE	26.09.24
G	AMENDMENTS TO COUNCIL	HE	13.01.23
F	AMENDMENTS TO COUNCIL	HE	24.11.22
E	AMENDED DA SUBMISSION	MA	23.09.22
D	AMENDED DA SUBMISSION	MA	22.12.21
C	ISSUE TO CONSULTANTS	MA	29.11.21
B	DA AMENDMENTS FOR COUNCIL REVIEW	MA	28.06.21
A	ISSUE FOR DEVELOPMENT APPROVAL	JA	21.08.20

Client: **SITEX PTY LTD**
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Architect: **LOUCAS ARCHITECTS**
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Level 3, Suite 309, 7-9 Gibbons St, Redfern NSW, Australia
Tel: (02) 8052 9600
Email: admin@loucasarc.com.au
Nominated Architect: Jim Apostolou 7490

Project Details: **MIXED USE DEVELOPMENT**
221-235 & 241 HOMER ST & 208 WARDELL RD EARLWOOD

Drawing Title: **ELEVATIONS**

Project Number: **Pn-24006**
Drawing Number: **A-020**
Drawing Status: **AUTHORITY APPROVAL**
Issue: **H**

SCHEDULE OF COLOURS & FINISHES:

-  R1
RENDER & PAINT
DULUX - DOMINO
-  BR
BRICK WALL
-  MC
METAL CLADDING
MINI ORB CLADDING
CONCRETE FINISH WALL
-  GB
FROSTED GLASS BALUSTRADE
-  TL
METAL CLADDING
TIMBER FINISH
LINING/LOUVERS
-  R2
RENDER & PAINT
DULUX - BROWN
-  AF1
ALUMINIUM FRAME
POWDER COAT FINISH
CHARCOAL GREY
WINDOWS AND DOORS



1 NORTH-WEST ELEVATION-LANE
SCALE 1:200 @ A1



2 NORTH-WEST ELEVATION-CUT THROUGH PODIUM
SCALE 1:200 @ A1

LEGEND


PROPOSED DA AMENDMENTS SHOWN IN BLUE

BASIX COMMITMENTS NOTES				
* TO BE READ IN CONJUNCTION WITH APPROVED BASIX REPORT*				
WATER				
Fixtures:	All Shower Heads 4 star (4.0-4.9) > 7.5L/min	All toilet flushing systems 4 star	All kitchen taps 4 star	All bathroom taps 5 star
Appliances:	Dishwashers - 5.0 star water rating			
Alternative water source:	Central rainwater tank - size 5000L to collect run-off from at least 269m ² of roof area and connection to allow for irrigation of 200m ² of common landscape area			
Fire:	Fire sprinklers are to be configured so that fire sprinkler test water is contained within the fire sprinkler system for re-use, rather than disposed.			
ENERGY	Hot water system: Central hot water system - gas instantaneous			
	Bedroom ventilation system: Individual fan, ducted to facade or roof manual switch on/off			
	Kitchen ventilation system: Individual fan, ducted to facade or roof manual switch on/off			
	Laundry ventilation system: Individual fan, ducted to facade or roof manual switch on/off			
REFER TO APPROVED BASIX	Cooling system: air-conditioning 1 Phase - EER 3.0-3.5 living/bed (zoned)			
	Heating system: air-conditioning 1 Phase - EER 3.0-3.5 living/bed (zoned)			
	Artificial lighting: As per BASIX			
	Natural lighting: As per BASIX			
Appliances:	Gas cooktop & electric oven in the kitchen of the dwellings			
	Dishwashers: 3.5 star energy rating			
	Alternative energy supply: Photovoltaic system - Rated electrical output (min): 21.0 peak kW			
COMMON AREAS	Refer to approved BASIX cert			

NATHERS summary for 221-235 & 241 Homer Street Earlowood 2206			
Building Elements	Material	Detail	
External walls - Levels 1 & 2	Brick veneer	R2.5 insulation (product value)	
External walls - Levels 3 to 6	Lightweight metal cladded walls	R2.5 insulation (product value)	
Internal walls within units	Plasterboard on studs	-	
Common walls between units & Corridors	Hobel + stud + Plasterboard	-	
Common walls between units	Hobel + stud + Plasterboard	-	
Common walls between units and lift shaft/fire stairs	200mm concrete	-	
Ceilings to nominated units	Plasterboard	R1.5 insulation (product value) to ceilings with roof to outside air units - A2.01, A2.07, A3.02, B2.01, B2.02, B3.01, C1.02, C1.04, C1.05	
Ceilings to top floor units	Plasterboard	R2.5 insulation (product value) to ceilings with roof above - B5.04, B9.05, C3.01, C3.02, C3.03 & Level 6 units	
Floors	Concrete	-	
Roof	Concrete roof	-	
Windows/Doors to all units except as stated below	Sliding windows/doors, fixed & loose windows: Aluminium frame, single glazed clear	U value 6.70 or less and SHGC 0.70 +/- 10%	
	Awing windows: Aluminium frame, single glazed clear	U value 6.70 or less and SHGC 0.57 +/- 10%	
Windows/Doors to units - A3.01, A3.07, A4.01, A4.06, A5.01, A5.06, A6.01, A6.06, B1.01, B1.05, B2.01, B2.05, B2.07, B3.01, B3.04, B4.01, B4.04, B5.01, B5.04, B6.01, B6.04, B7.01, B7.04, B8.01, B8.04, C1.01, C1.03	Sliding windows/doors, fixed windows: Aluminium frame, double glazed low e or similar	U value 4.30 or less and SHGC 0.53 +/- 10%	
	Awing windows: Aluminium frame, single glazed low e or similar	U value 5.40 or less and SHGC 0.49 +/- 10%	
Ceiling fans	1200mm ceiling fans to living and bedrooms - Units B1.03, 2.03	1200mm ceiling fans to living only - Units B3.02, B4.02, B5.02, B6.02	

Lighting: Units have been rated with non-ventilated LED downlights as per NATHERS coefficients.
Note: In some climate zones, insulation should be installed with due consideration of condensation and associated interaction with adjoining building materials.
Note: Self-closing door to bathroom and shower exhaust fans.
Note: Additional insulation may be required to meet specific requirements.
Building & Energy Consultants Australia disclaims liability from any responsibility associated with the selection of insulation, sarking type materials, thermal breaks and other components which fail to comply with the fire safety requirements provisions under Part C of the BCA.

Scale: 1:200 @A1 1:400 @A3

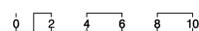

Date Printed:

ISSUE	REVISION DESCRIPTION
H	ISSUE FOR DA AMENDMENTS
G	AMENDMENTS TO COUNCIL
F	AMENDMENTS TO COUNCIL
E	AMENDED DA SUBMISSION
D	AMENDED DA SUBMISSION
C	ISSUE TO CONSULTANTS
B	DA AMENDMENTS FOR COUNCIL REVIEW
A	ISSUE FOR DEVELOPMENT APPROVAL

APPD	DATE
HE	26.09.24
HE	24.11.22
HE	21.10.22
MA	23.09.22
MA	22.12.21
MA	29.11.21
MA	28.06.21
JA	21.08.20

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Tel: (02) 8052 9600
Email: admin@loucasarc.com.au
Nominated Architect:
Jim Apostolou 7490



Project Details:
MIXED USE DEVELOPMENT
221-235 & 241 HOMER ST
& 208 WARDELL RD
EARLOWOOD

Drawing Title:
ELEVATIONS

Project Number:
Pn-24006


Drawing Number:
A-021

Drawing Status:
AUTHORITY APPROVAL

Issue:
H


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SCHEDULE OF COLOURS & FINISHES:

	R1 RENDER & PAINT DULUX - DOMINO
	BR BRICK WALL
	MC METAL CLADDING MINI ORB CLADDING CONCRETE FINISH WALL
	GB FROSTED GLASS BALUSTRADE
	TL METAL CLADDING TIMBER FINISH LINING/LOUVERS
	R2 RENDER & PAINT DULUX - BROWN
	AF1 ALUMINIUM FRAME POWDER COAT FINISH CHARCOAL GREY WINDOWS AND DOORS

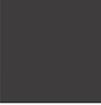

1 NORTH-EAST ELEVATION
SCALE 1:200 @ A1

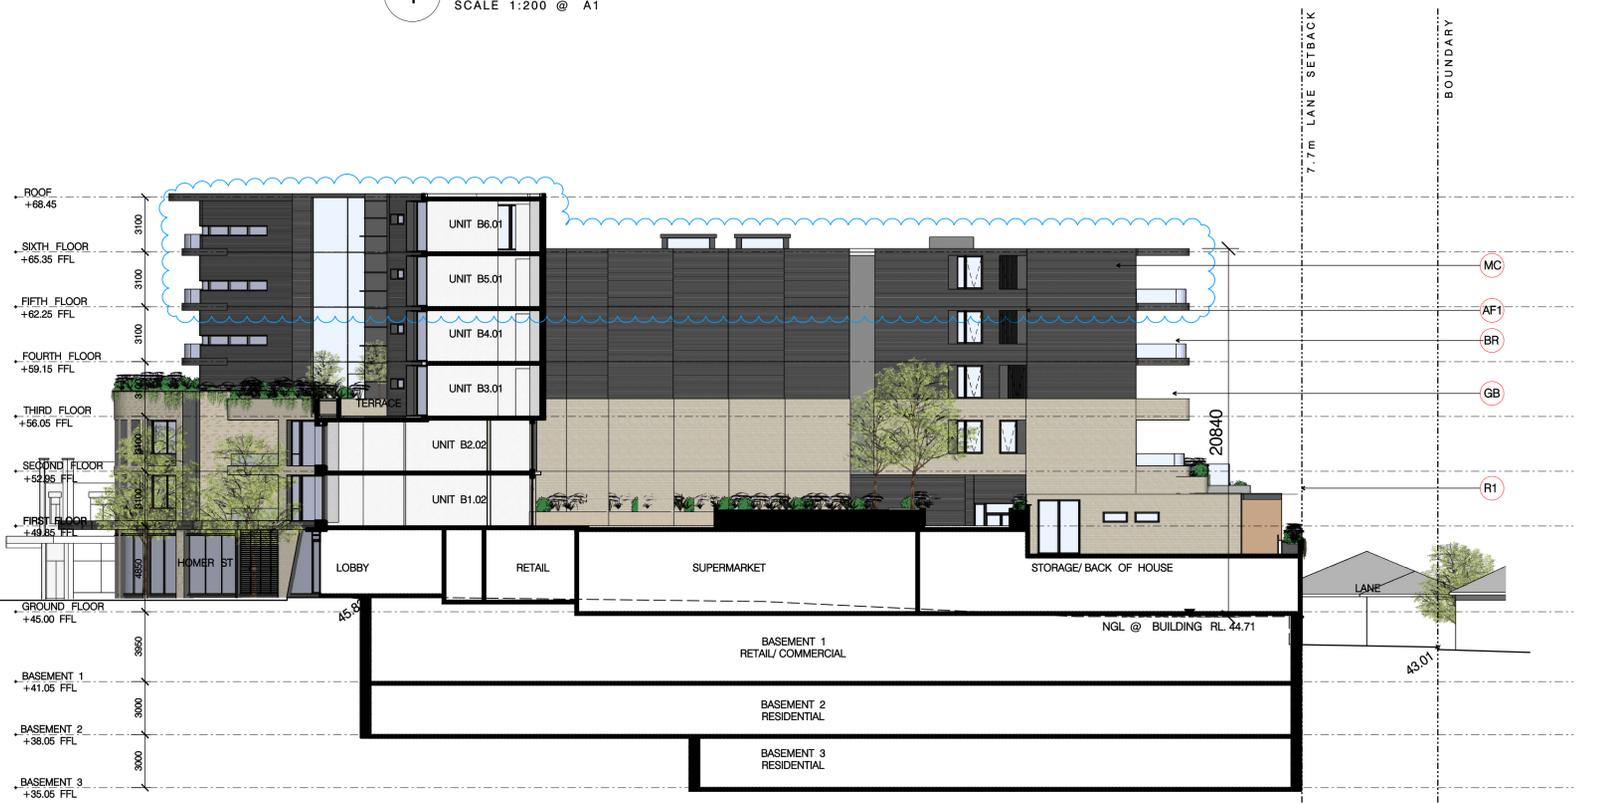

2 EAST ELEVATION-CUT THROUGH PODIUM
SCALE 1:200 @ A1

LEGEND

— PROPOSED DA AMENDMENTS SHOWN IN BLUE

BASIX COMMITMENTS NOTES				
* TO BE READ IN CONJUNCTION WITH APPROVED BASIX REPORT *				
WATER	Fixtures	All Shower Heads 4 star (400L-7.5L/min)	All toilet flushing systems 4 star	All kitchen taps 4 star
	Appliances:	Dishwashers - 5.0 star water rating		
	Alternative water source	Central rainwater tank - size 5000L to collect run-off from at least 269m ² of roof area and connection to allow for irrigation of 200m ² of common landscape area		
	Fire sprinklers	Fire sprinklers are to be configured so that fire sprinkler test water is contained within the fire sprinkler system for re-use, rather than disposed.		
	ENERGY	Hot water system: Central hot water system - gas instantaneous		
	REFER TO APPROVED BASIX	Bathroom ventilation system: Individual fan, ducted to façade or roof manual switch on/off		
		Kitchen ventilation system: Individual fan, ducted to façade or roof manual switch on/off		
		Laundry ventilation system: Individual fan, ducted to façade or roof manual switch on/off		
		Cooling system: air-conditioning 1 Phase - EER 3.0-3.5 living/bed (zoned)		
		Heating system: air-conditioning 1 Phase - EER 3.0-3.5 living/bed (zoned)		
		Artificial lighting: As per BASIX		
		Natural lighting: As per BASIX		
	Appliances:	Gas cooktop & electric oven in the kitchen of the dwellings		
		Dishwashers: 3.5 star energy rating		
		Alternative energy supply: Photovoltaic system - Rated electrical output (min): 21.0 peak kW		
COMMON AREAS		Refer to approved BASIX cert		

NATHERS summary for 221-235 & 241 Homer Street Earwood 2206		
Building Elements	Material	Detail
External walls - Levels 1 & 2	Brick veneer	R2.5 insulation (product value)
External walls - Levels 3 to 6	Lightweight metal clad/brick walls	R2.5 insulation (product value)
Internal walls within units	Plasterboard on studs	-
Common walls between units & Corridors	Hobbit stud + Plasterboard	-
Common walls between units	Hobbit stud + Plasterboard	-
Common walls between units and lift shaft/fire stairs	200mm concrete	-
Ceilings to nominated units	Plasterboard	R1.5 insulation (product value) to ceilings with roof to outside air units - A2.01, A2.07, A3.02, B2.01, B2.02, B2.03, C1.02, C1.03, C1.04, C1.05
Ceilings to top floor units	Plasterboard	R2.5 insulation product value to ceilings with roof above - B5.04, B5.05, C5.01, C5.02, C5.03 & Level 6 units
Floors	Concrete	-
Roof	Concrete roof	-
Windows/Doors to all units except as stated below	Sliding windows/doors, fixed & louvre windows: Aluminium frame, single glazed clear	U value 6.70 or less and SHGC 0.70 +/- 10%
	Fixed windows: Aluminium frame, single glazed clear	U value 6.70 or less and SHGC 0.57 +/- 10%
Windows/Doors to units - A3.01, A3.07, A4.01, A4.06, A5.01, A5.06, A6.01, A6.06, B1.04, B1.05, B2.02, B2.03, B2.05, B3.01, B3.02, B3.04, B4.02, B4.04, B5.02, B5.04, B6.01, B.602, C1.02, C1.03	Sliding windows/doors, fixed windows: Aluminium frame, double glazed low e or similar	U value 4.30 or less and SHGC 0.53 +/- 10%
	Fixed windows: Aluminium frame, double glazed low e or similar	U value 5.40 or less and SHGC 0.25 +/- 10%
Ceiling fans	1200mm ceiling fans to living and bedrooms - Units B1.03, 2.03	1200mm ceiling fans to living only - Units B3.02, B4.02, B5.02, B6.02

Scale: 1:200 @A1 1:400 @A3

Date Printed: 25/10/2024

ISSUE	REVISION DESCRIPTION	APPD	DATE
F	ISSUE FOR DA AMENDMENTS	HE	26.09.24
E	AMENDED DA SUBMISSION	MA	23.09.22
D	AMENDED DA SUBMISSION	MA	22.12.21
C	ISSUE TO CONSULTANTS	MA	29.11.21
B	DA AMENDMENTS FOR COUNCIL REVIEW	MA	28.06.21
A	ISSUE FOR DEVELOPMENT APPROVAL	JA	21.08.20

Client: **SITEX PTY LTD**

HE	MA	JA
26.09.24	23.09.22	21.08.20

Architect: **LOUCAS ARCHITECTS**
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Tel: (02) 8052 9600
Email: admin@loucasarc.com.au
Nominated Architect: Jim Apostolou 7490



Project Details: **MIXED USE DEVELOPMENT**
221-235 & 241 HOMER ST & 208 WARDELL RD EARLWOOD

Drawing Title: **ELEVATIONS**

Project Number: **Pn-24006**

Drawing Status: **AUTHORITY APPROVAL**

Drawing Number: **A-022**

Issue: **F**

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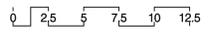


1 NORTH-EAST ELEVATION
SCALE 1:250 @ A1



2 EAST ELEVATION-CUT THROUGH PODIUM
SCALE 1:250 @ A1

Scale: 1:250 @A1 1:500 @A3



Date Printed:
25/10/2024

ISSUE	REVISION DESCRIPTION
F	ISSUE FOR DA AMENDMENTS
E	AMENDED DA SUBMISSION
D	AMENDED DA SUBMISSION
C	ISSUE TO CONSULTANTS
B	DA AMENDMENTS FOR COUNCIL REVIEW
A	ISSUE FOR DEVELOPMENT APPROVAL

APPD	DATE	REVISION DESCRIPTION
HE	26.09.24	
MA	23.09.22	
MA	22.12.21	
MA	29.11.21	
MA	28.06.21	
JA	21.08.20	

Client:
SITEX PTY LTD

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Redfern NSW, Australia
Tel: (02) 8052 9600
Email: admin@loucasarc.com.au


Architect:
LOUCAS ARCHITECTS
ABN 92 626 290 122

Level 3, Suite 309, 7-9 Gibbons St,
Redfern NSW, Australia
Tel: (02) 8052 9600
Email: admin@loucasarc.com.au
Nominated Architect:
Jim Apostolou 7490

Project Details:
MIXED USE DEVELOPMENT
221-235 & 241 HOMER ST
& 208 WARDELL RD
EARLWOOD

Drawing Title:
STREETSCAPE ELEVATIONS

Project Number: Pn-24006	Drawing Number: A-023
Drawing Status: AUTHORITY APPROVAL	Issue: F
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1 SECTION 1

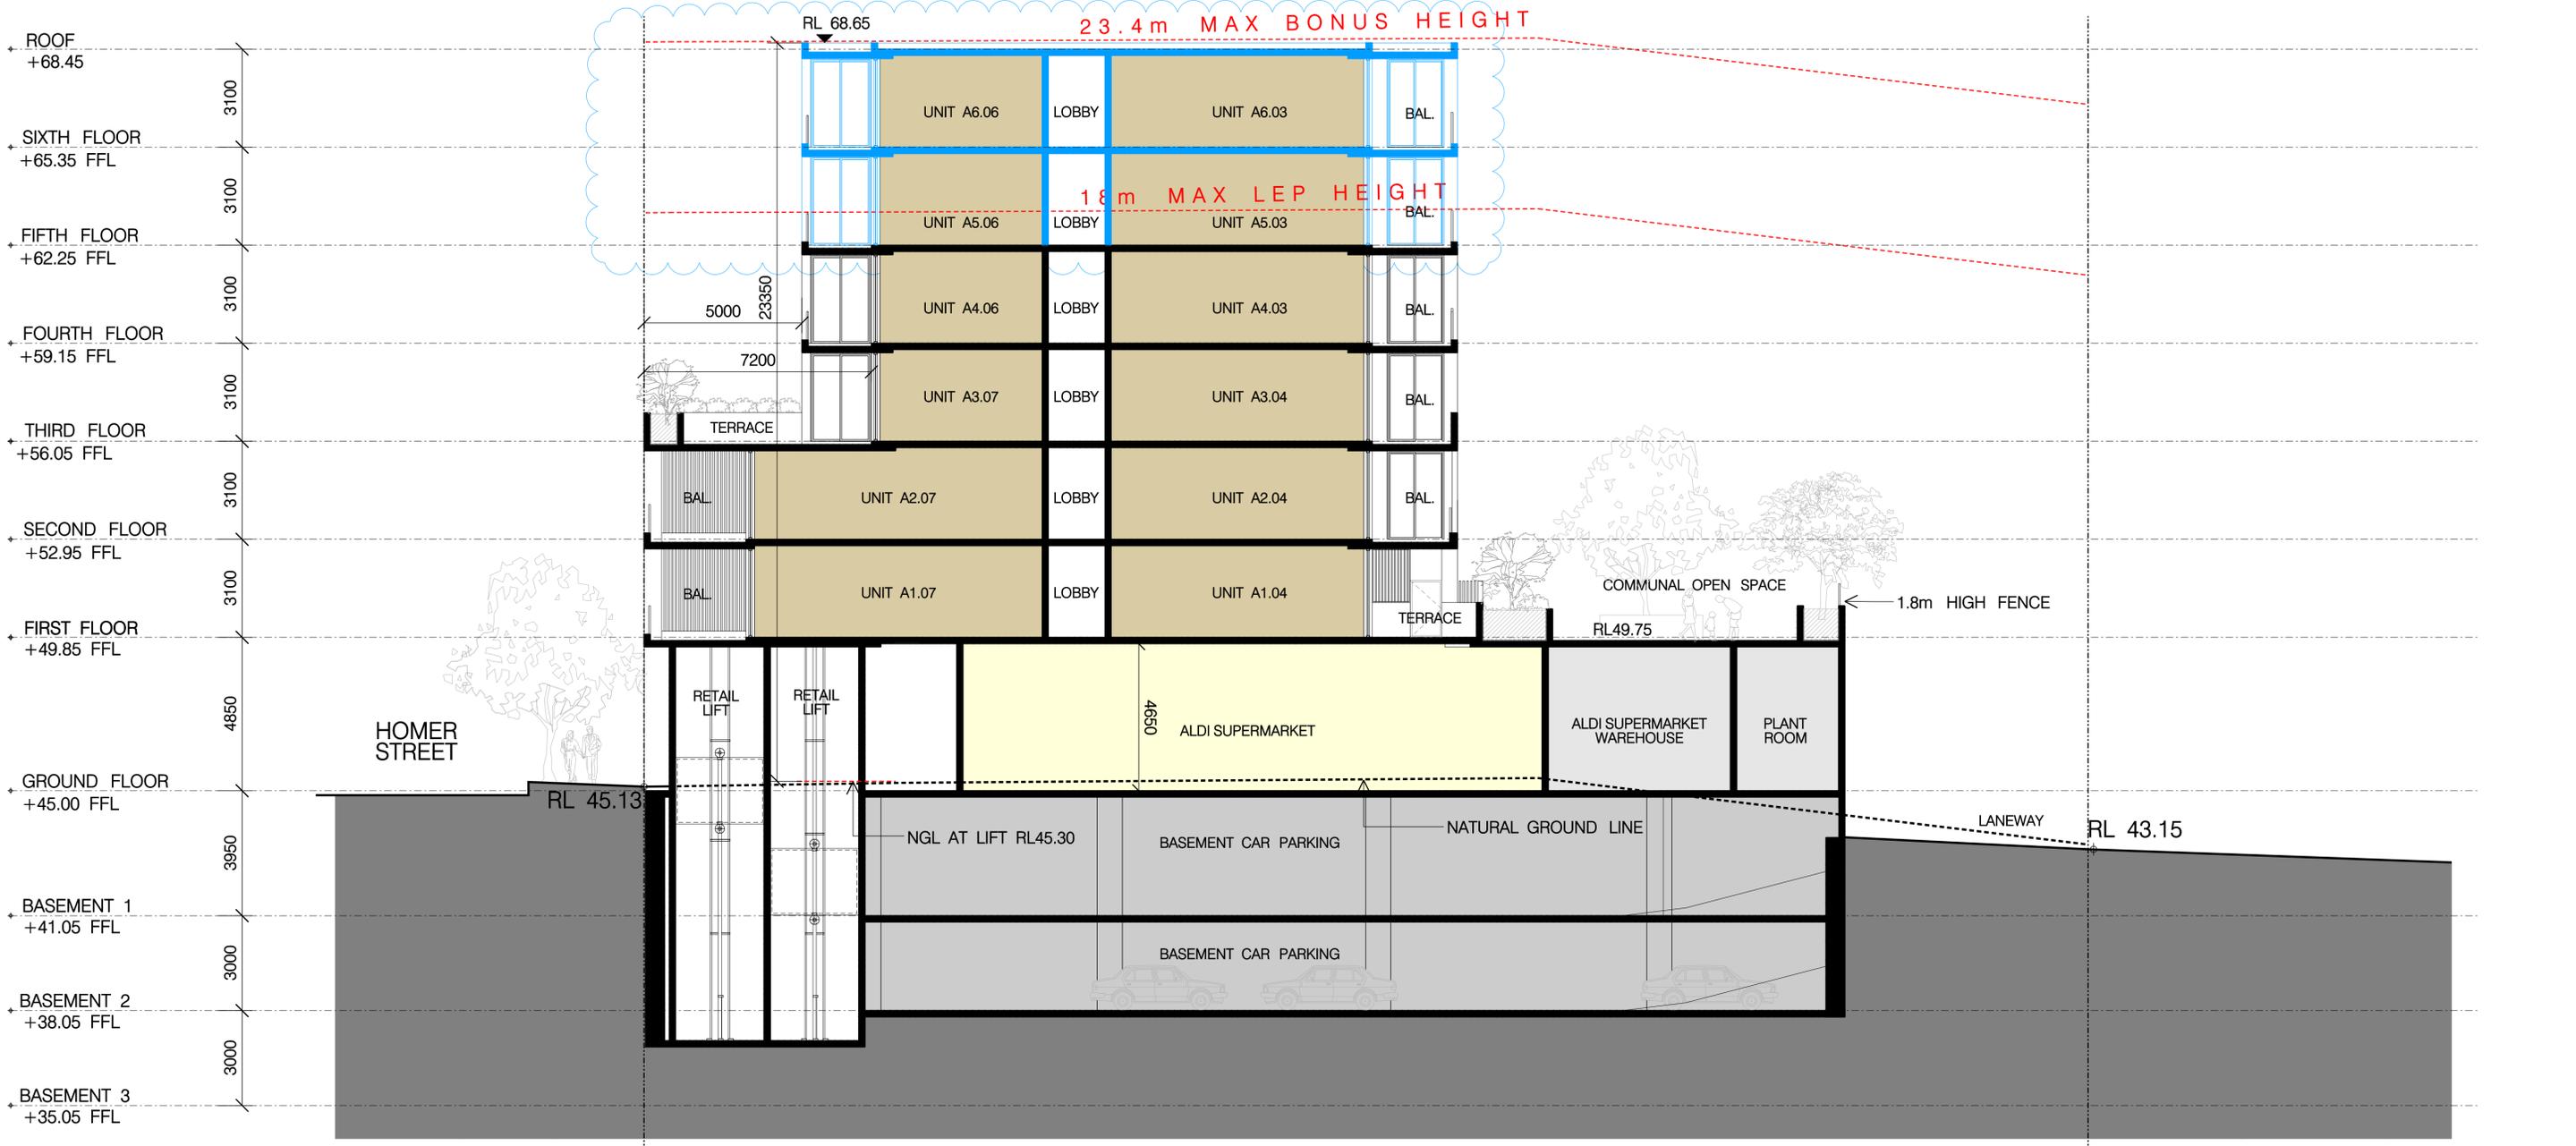LEGEND

PROPOSED DA AMENDMENTS SHOWN IN BLUE

BASIX COMMITMENTS NOTES			
* TO BE READ IN CONNECTION WITH APPROVED BASIX REPORT *			
WATER			
Fixtures	All Shower Heads 4 star (4-bucket < 7.5l/min)	All toilet flushing systems 4 star	All kitchen taps 4 star
			All bathroom taps 5 star
Appliances:	Dishwashers - 5.0 star water rating		
Alternative water source	Central rainwater tank - size 5000L to collect run-off from at least 260m ² of roof area and connection to allow for irrigation of 200m ² of common landscape area		
Fire	Fire sprinklers are to be configured so that fire sprinkler test water is contained within the fire sprinkler system for re-use, rather than disposed.		
ENERGY	Hot water system: Central hot water system - gas instantaneous		
	Bathroom ventilation system: Individual fan, ducted to facade or roof manual switch on/off		
	Kitchen ventilation system: Individual fan, ducted to facade or roof manual switch on/off		
	Laundry ventilation system: Individual fan, ducted to facade or roof manual switch on/off		
REFER TO APPROVED BASIX	Cooling system: air-conditioning 1 Phase - EER 3.0-3.5 living/bed (zoned)		
	Heating system: air-conditioning 1 Phase - EER 3.0-3.5 living/bed (zoned)		
	Artificial lighting: As per BASIX		
	Natural lighting: As per BASIX		
Appliances:	Gas cooktop & electric oven in the kitchen of the dwellings		
	Dishwashers: 3.5 star energy rating		
	Alternative energy supply: Photovoltaic system - Rated electrical output (min): 21.0 peak kW		
COMMON AREAS	Refer to approved BASIX cert		

NATHERS summary for 221-235 & 241 Homer Street Earlwood 2206		
Building Elements	Material	Detail
External walls - Levels 1 & 2	Brick veneer	R2.5 insulation (product value)
External walls - Levels 3 to 6	Lightweight metal clad walls	R2.5 insulation (product value)
Internal walls within units	Plasterboard on studs	-
Common walls between units & Corridors	Hebel + stud + Plasterboard	-
Common walls between units	Hebel + stud + Plasterboard	-
Common walls between units and lift shaft/fire stairs	200mm concrete	-
Ceilings to nominated units	Plasterboard	R1.5 insulation (product value) to ceilings with roof to outside air units - A2.01, A2.07, A3.02, B2.01, B2.02, B2.03, C1.02, C1.03, C1.04, C1.05
Ceilings to top floor units	Plasterboard	R2.5 insulation (product value) to ceilings with roof above - B5.04, B5.05, C5.01, C5.02, C5.03 & Level 6 units
Floors	Concrete	-
Roof	Concrete roof	-
Windows/Doors to all units except as stated below	Sliding windows/doors, fixed & loose windows: Aluminium frame, single glazed clear	U value 6.70 or less and SHGC 0.70 +/- 10%
	Awing windows: Aluminium frame, single glazed clear	U value 6.70 or less and SHGC 0.57 +/- 10%
Windows/Doors to units - A3.01, A3.07, A4.01, A4.06, A5.01, A5.06, A6.01, A6.06, B1.05, B2.02, B2.05, B3.01, B3.02, B3.04, B4.02, B4.04, B5.02, B5.04, B6.01, B.602, C1.02, C1.03	Sliding windows/doors, fixed windows: Aluminium frame, double glazed low e or similar	U value 4.30 or less and SHGC 0.53 +/- 10%
	Awing windows: Aluminium frame, single glazed low e or similar	U value 5.40 or less and SHGC 0.49 +/- 10%
Ceiling fans	1200mm ceiling fans to living and bedrooms - Units B3.03, 3.03	• 1200mm ceiling fans to living only - Units B3.02, B4.02, B5.02, B6.02

True North

Scale: 1:100 @A1 1:200 @A3

Date Printed: 25/10/2024

ISSUE	REVISION DESCRIPTION	APPD	DATE
F	ISSUE FOR DA AMENDMENTS	HE	26.09.24
E	AMENDED DA SUBMISSION	MA	23.09.22
D	AMENDED DA SUBMISSION	MA	22.12.21
C	ISSUE TO CONSULTANTS	MA	29.11.21
B	DA AMENDMENTS FOR COUNCIL REVIEW	MA	28.06.21
A	ISSUE FOR DEVELOPMENT APPROVAL	JA	21.08.20

Client: **SITEX PTY LTD**

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Architect: **LOUCAS ARCHITECTS**
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Email: admin@loucasarc.com.au
Nominated Architect: Jim Apostolou 7490

Project Details: **MIXED USE DEVELOPMENT**
221-235 & 241 HOMER ST & 208 WARDELL RD EARLWOOD

Drawing Title: **SECTION 1 AND DRIVEWAY SECTION**


Project Number: **Pn-24006**

Drawing Number: **A-030**

Drawing Status: **AUTHORITY APPROVAL**

Issue: **F**

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LEGEND

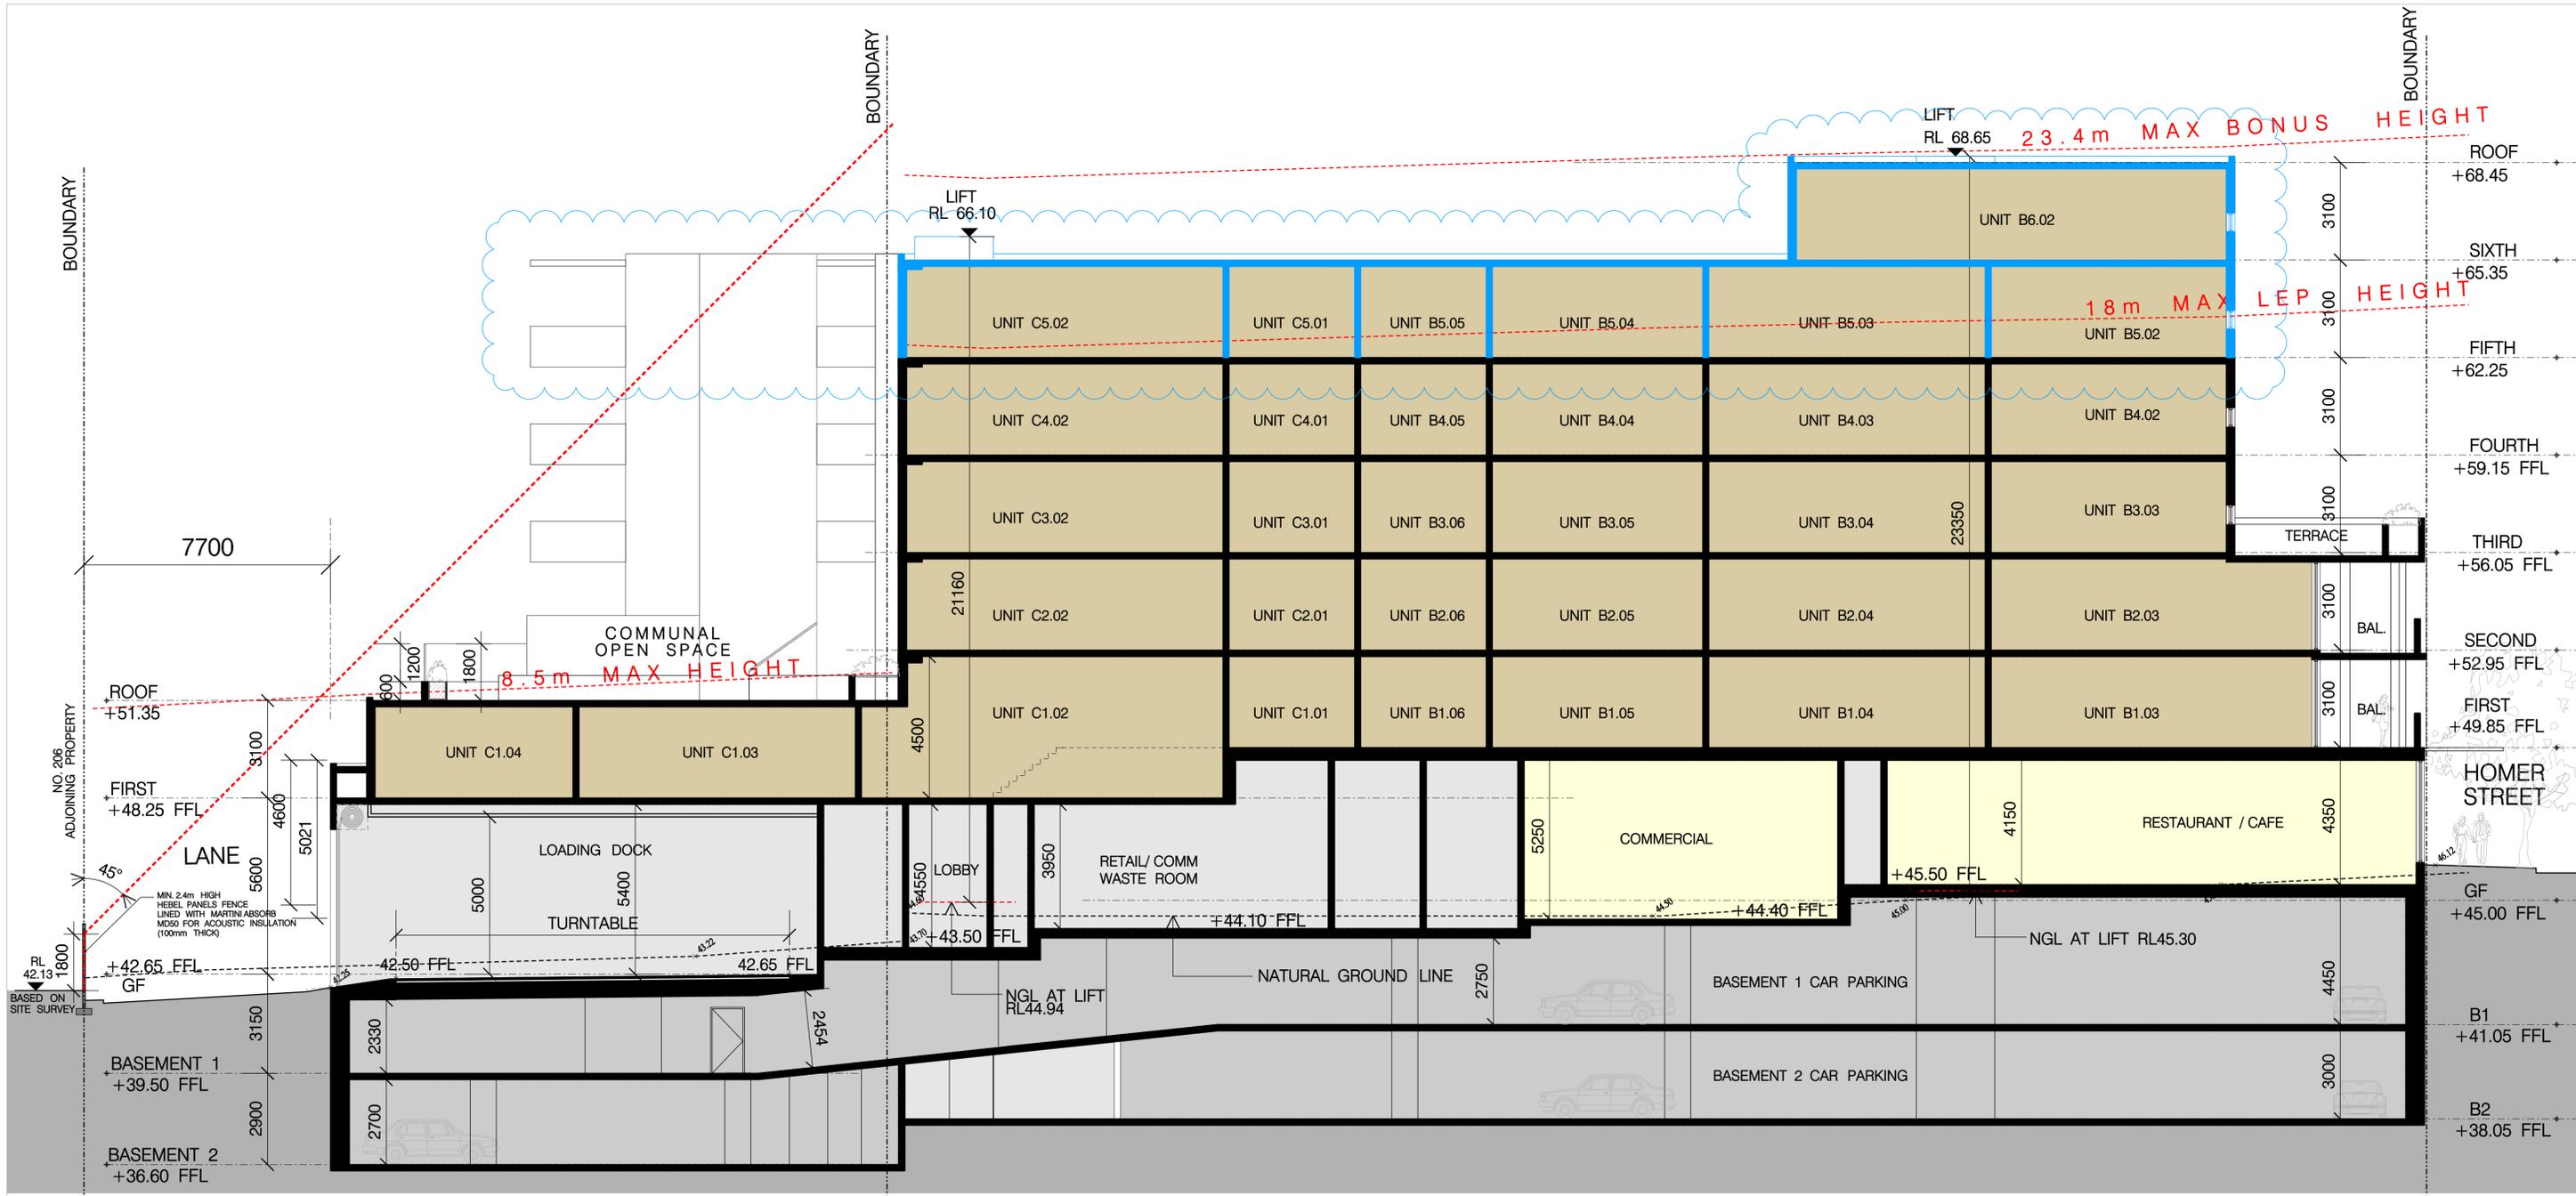PROPOSED DA AMENDMENTS SHOWN IN BLUE

BASIX COMMITMENTS NOTES			
* TO BE READ IN CONJUNCTION WITH APPROVED BASIX REPORT *			
WATER	Fixtures: All Shower Heads, 4 star (4000-7.5L/min)	All toilet flushing systems, 4 star	All kitchen taps, 4 star
Alternative water source	Central rainwater tank - size 5000L to collect run-off from at least 250m ² of roof area and connection to allow for irrigation of 200m ² of common landscape area		
ENERGY	Fire sprinklers: Fire sprinklers are to be configured so that fire sprinkler test water is contained within the fire sprinkler system for re-use, rather than disposed.		
REFER TO APPROVED BASIX	Bathrooms: Individual fan, ducted to facade or roof manual switch on/off Kitchen ventilation system: Individual fan, ducted to facade or roof manual switch on/off Laundry ventilation system: Individual fan, ducted to facade or roof manual switch on/off Heating system: air-conditioning 1 Phase - EER 3.0-3.5 living/bed (zoned) Artificial lighting: As per BASIX Natural lighting: As per BASIX Appliances: Gas cooktop & electric oven in the kitchen of the dwellings Dishwashers: 3.5 star energy rating Alternative energy supply: Photovoltaic system - Rated electrical output (min): 21.0 peak kW Refer to approved BASIX cert		
COMMON AREAS	Refer to approved BASIX cert		

NotHERS summary for 221-235 & 241 Homer Street Earwood 2206			
Building Elements	Material	Detail	
External walls - Levels 1 & 2	Brick veneer	R2.5 insulation (product value)	
External walls - Levels 3 to 6	Lightweight metal clad walls	R2.5 insulation (product value)	
Internal walls within units	Plasterboard on studs	-	
Common walls between units & Corridors	Hebel + stud + Plasterboard	-	
Common walls between units	Hebel + stud + Plasterboard	-	
Common walls between units and lift shaft/fire stairs	200mm concrete	-	
Stairs to nominated units	Plasterboard	R1.5 insulation (product value) to ceilings with roof to outside air units - A2.01, A2.02, A3.02, B2.01, B2.02, B2.03, C1.02, C1.03, C1.04, C1.05	
Ceilings to top floor units	Plasterboard	R2.5 insulation (product value) to ceilings with roof above - B5.04, B5.05, C5.03, C5.02, C5.03 & Level 6 units	
Floors	Concrete	-	
Roof	Concrete roof	-	
Windows/Doors to all units except as stated below	Sliding windows/doors, fixed & louvre windows: Aluminium frame, single glazed clear	U value 6.70 or less and SHGC 0.70 +/- 10%	
Awning windows:	Aluminium frame, double glazed low e or similar	U value 6.70 or less and SHGC 0.57 +/- 10%	
Windows/Doors to units - A3.01, A3.02, A4.01, A4.02, A5.01, A5.02, A6.01, A6.02, B1.03, B1.05, B2.02, B2.03, B2.05, B3.01, B3.02, B3.04, B4.02, B4.04, B5.02, B5.04, B6.01, B6.02, C1.02, C1.03	Sliding windows/doors, fixed windows: Aluminium frame, double glazed low e or similar	U value 4.30 or less and SHGC 0.53 +/- 10%	
Awning windows:	Aluminium frame, single glazed low e or similar	U value 5.40 or less and SHGC 0.49 +/- 10%	
Ceiling fans	1200mm ceiling fans to living and bedrooms - Units B1.03, 2.03 + 1200mm ceiling fans to living only - Units B3.02, B4.02, B5.02, B6.02	-	
Lighting: Units have been rated with non-ventilated LED downlights as per NotHERS Certificates.			
Note: In some climate zones, insulation should be installed with due consideration of condensation and associated interaction with adjoining building materials.			
Note: Self-closing doors to bathroom and ensuite exhaust fans.			
Note: Additional insulation may be required to meet acoustic requirements.			
Building & Energy Consultants Australia discloses itself from any responsibility associated with the selection of insulation, sarking type materials, thermal breaks and other components which fail to comply with the fire safety requirement provisions under Part 5 of the BCA.			

True North

Scale: 1:100 @A1 1:200 @A3

Date Printed: 25/10/2024

ISSUE	REVISION DESCRIPTION	APPD	DATE
I	ISSUE FOR DA AMENDMENTS	HE	26.09.24
H	AMENDMENTS TO COUNCIL	HE	23.01.23
G	AMENDMENTS TO COUNCIL	HE	13.01.23
F	AMENDMENTS TO COUNCIL	HE	24.11.22
E	AMENDED DA SUBMISSION	MA	23.09.22
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Nominated Architect: Jim Apostolou 7490

Project Details: **MIXED USE DEVELOPMENT**

221-235 & 241 HOMER ST & 208 WARDELL RD EARLWOOD

Drawing Title: **SECTION 2**

Project Number: **Pn-24006**

Drawing Status: **AUTHORITY APPROVAL**

Drawing Number: **A-031**

Issue: **I**

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True North

Scale: 1:100 @A1 1:200 @A3

Date Printed:
25/10/2024

ISSUE	REVISION DESCRIPTION	APPD	DATE
D	AMENDED DA SUBMISSION	MA	22.12.21
C	ISSUE TO CONSULTANTS	MA	29.11.21
B	DA AMENDMENTS FOR COUNCIL REVIEW	MA	28.06.21
A	ISSUE FOR DEVELOPMENT APPROVAL	JA	21.08.20

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Nominated Architect:
Jim Apostolou 7490

Project Details:
MIXED USE DEVELOPMENT
221-235 & 241 HOMER ST
& 208 WARDELL RD
EARLWOOD

Drawing Title:
DETAILED SECTION

Project Number: Pn-24006	Drawing Number: A-032
Drawing Status: AUTHORITY APPROVAL	Issue: D

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